


1 BELOW GRADE - LIGHTING - ELECTRICAL
SCALE: 1/8" = 1'-0"

GENERAL NOTES: (SHEET E2.2)


1. CONTRACTOR SHALL NOT ALTER FIXTURE COUNTS WITHOUT ENGINEER'S APPROVAL.
2. CONTRACTOR SHALL COORDINATE EXACT LOCATIONS AND MOUNTING HEIGHTS OF ALL EXTERIOR FIXTURES WITH ARCH. ELEVATIONS.

REFERENCE NOTES: (SHEET E2.2)


1. CONTRACTOR SHALL PROVIDE A LEVITON DIMMER PANEL OF MODEL A2D3L-112, OR APPROVED EQUAL, FOR CONTROL OF THE LED RANGE LIGHTING. CONTRACTOR SHALL ALSO PROVIDE AND INSTALL (6) DIMMER MODULES OF MODEL A2DUN-12, OR APPROVED EQUAL. CONTRACTOR SHALL PROVIDE AND INSTALL A LIGHTING CONTRROLLER OF MODEL D4200-1LW, OR APPROVED EQUAL. CONTRACTOR SHALL BE RESPONSIBLE FOR THE PROVISION AND INSTALLATION OF ALL APPROPRIATE APPURTENANCES REQUIRED FOR A COMPLETE AND FUNCTIONING DIMMING SYSTEM.
2. INTERCEPT PARKING LOT LIGHTING CIRCUITRY.
3. CONTRACTOR SHALL PROVIDE AND INSTALL A RED LAMP COVER OVER THE CENTER LAMP. CONTRACTOR SHALL SWITCH CENTER LAMP INDEPENDENTLY.
4. CONTRACTOR SHALL MOUNT FIXTURE TO BEAM.
5. INTERCEPT LIGHTING CIRCUITRY TO RED LAMP NIGHT LIGHT MENTIONED IN NOTE 12 ON SHEET E1.2.
6. CONTRACTOR SHALL PROVIDE AND INSTALL PA SYSTEM AND ALL APPROPRIATE APPURTENANCES TO PROVIDE A COMPLETE AND FUNCTIONING RANGE COMMUNICATIONS SYSTEM. SYSTEM SHALL COMPLY WITH SPECIFICATIONS. COORDINATE EXACT LOCATION OF PA SYSTEM EQUIPMENT WITH OWNER'S REPRESENTATIVE.

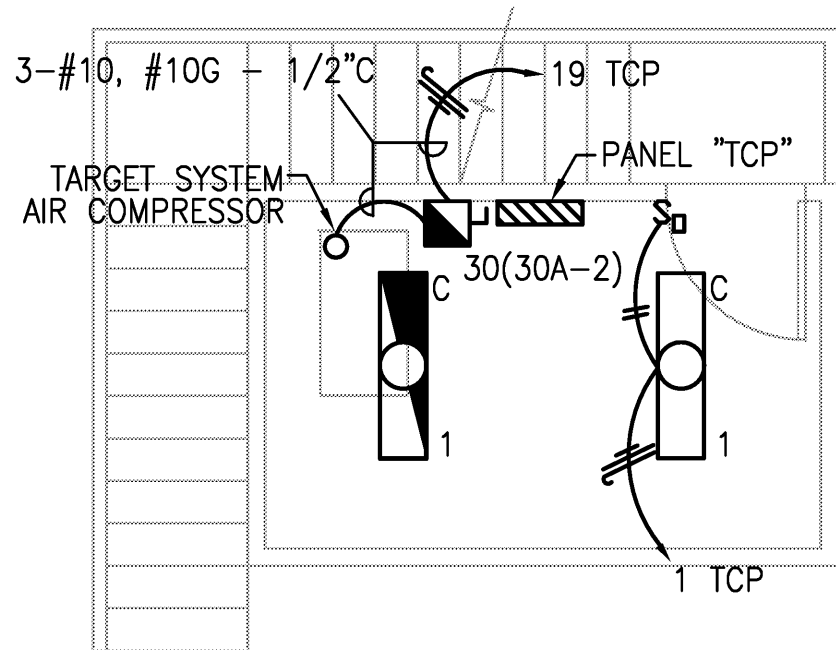

2 CONTROL TOWER - LOWER FLOOR PLAN - ELECTRICAL
SCALE: 1/8" = 1'-0"

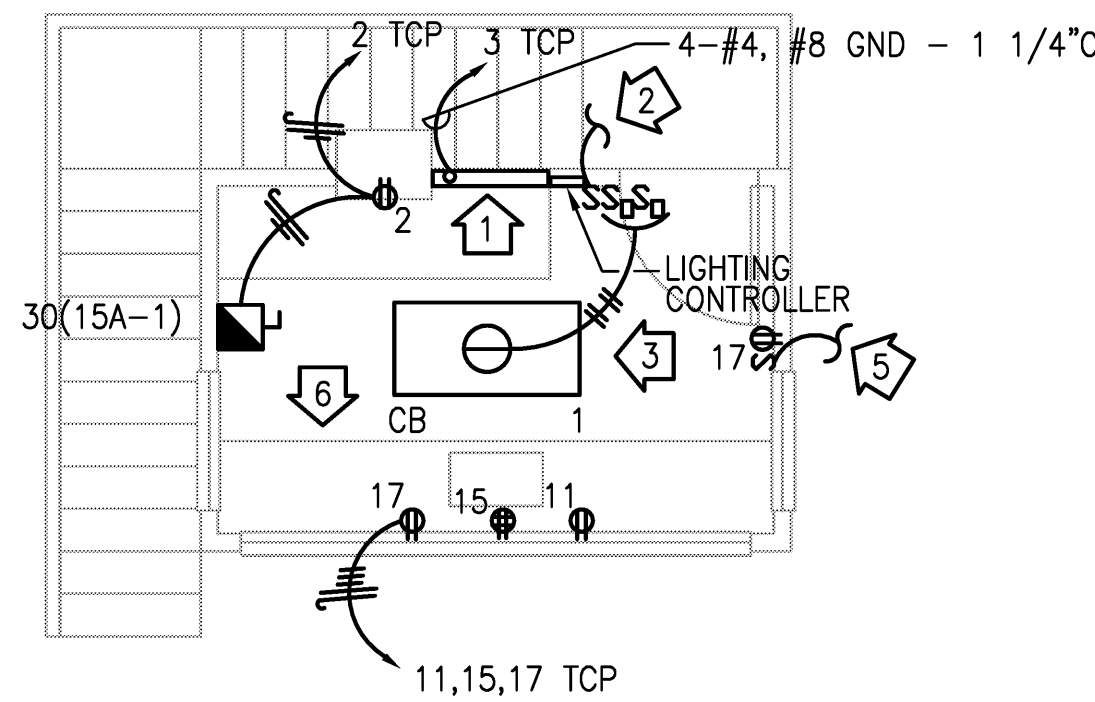

3 CONTROL TOWER - UPPER FLOOR PLAN - ELECTRICAL
SCALE: 1/8" = 1'-0"

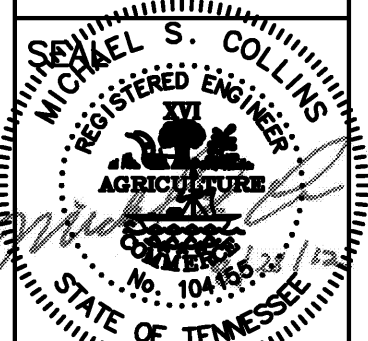

REVISIONS:

DATE:
AUGUST 28, 2012

DRAWN BY:
KES

SHEET TITLE:
BELOW GRADE
PLAN -
LIGHTING -
ELECTRICAL

SHEET NO:

E2.2